

STAIR NOTES

- 1. See sheet A1.03 for guardrail and handrail notes.
- Stairways shall not be less than 36 inches in clear width at all points above the permitted handrail height and below the required headroom height. IRC R311.5.1
- 3. Handrails shall not project more than 4 1/2 inches on either side of the stairway and the minimum clear width of the stairway at and below the handrail, including treads and landings, shall not be less than 31 1/2 inches where a handrail is installed on one side and 27 inches where handrails are provided on both sides. IRC R311.5.1
- 4. The maximum riser height shall be 7 3/4" inches. IRC R311.5.3.1
- 5. The riser shall be measured vertically between leading edges of the adjacent treads. IRC
- 6. The greates riser height within any flight of stairs shall not exceed the smallest by more than 3/8 inch. IRC R311.5.3.1
- 7. The minimum tread depth shall be 10 inches. IRC R311.3.2
- The tread depth shall be measured horizontally between the vertical planes of the foremost projection of adjacent treads and at a right angle to the tread's leading edge. IRC R311.3.2
- 9. The greatest tread within any flight of stairs shall not exceed the smallest by more than 3/8 inch. IRC R311.3.2
- 10. The radius curvature at the leading edge of the tread shall be no greater than 9/16 inch.
- 11. A nosing of not less than 3/4 inch but not more than 1 1/4 inches shall be provided on stairways with solid risers. IRC R311.5.3.3
- 12. The greates nosing projection shall not exceed the smallest nosing projection by more than 3/8 inch between two stories, including the nosing at the level of floors and landings. IRC R311.5.3.3
- 13. Beveling of nosings shall not exceed 1/2 inch. IRC R311.5.3.3
- 14. Risers thall be vertical or sloped from the underside of the leading edge of the tread above at an angle not more than 30 degrees from the vertical. IRC R311.5.3.3
- 15. Where risers are open, the opening between the treads shall not permit the passage of a 4 inch diameter sphere. IRC R311.5.3.3

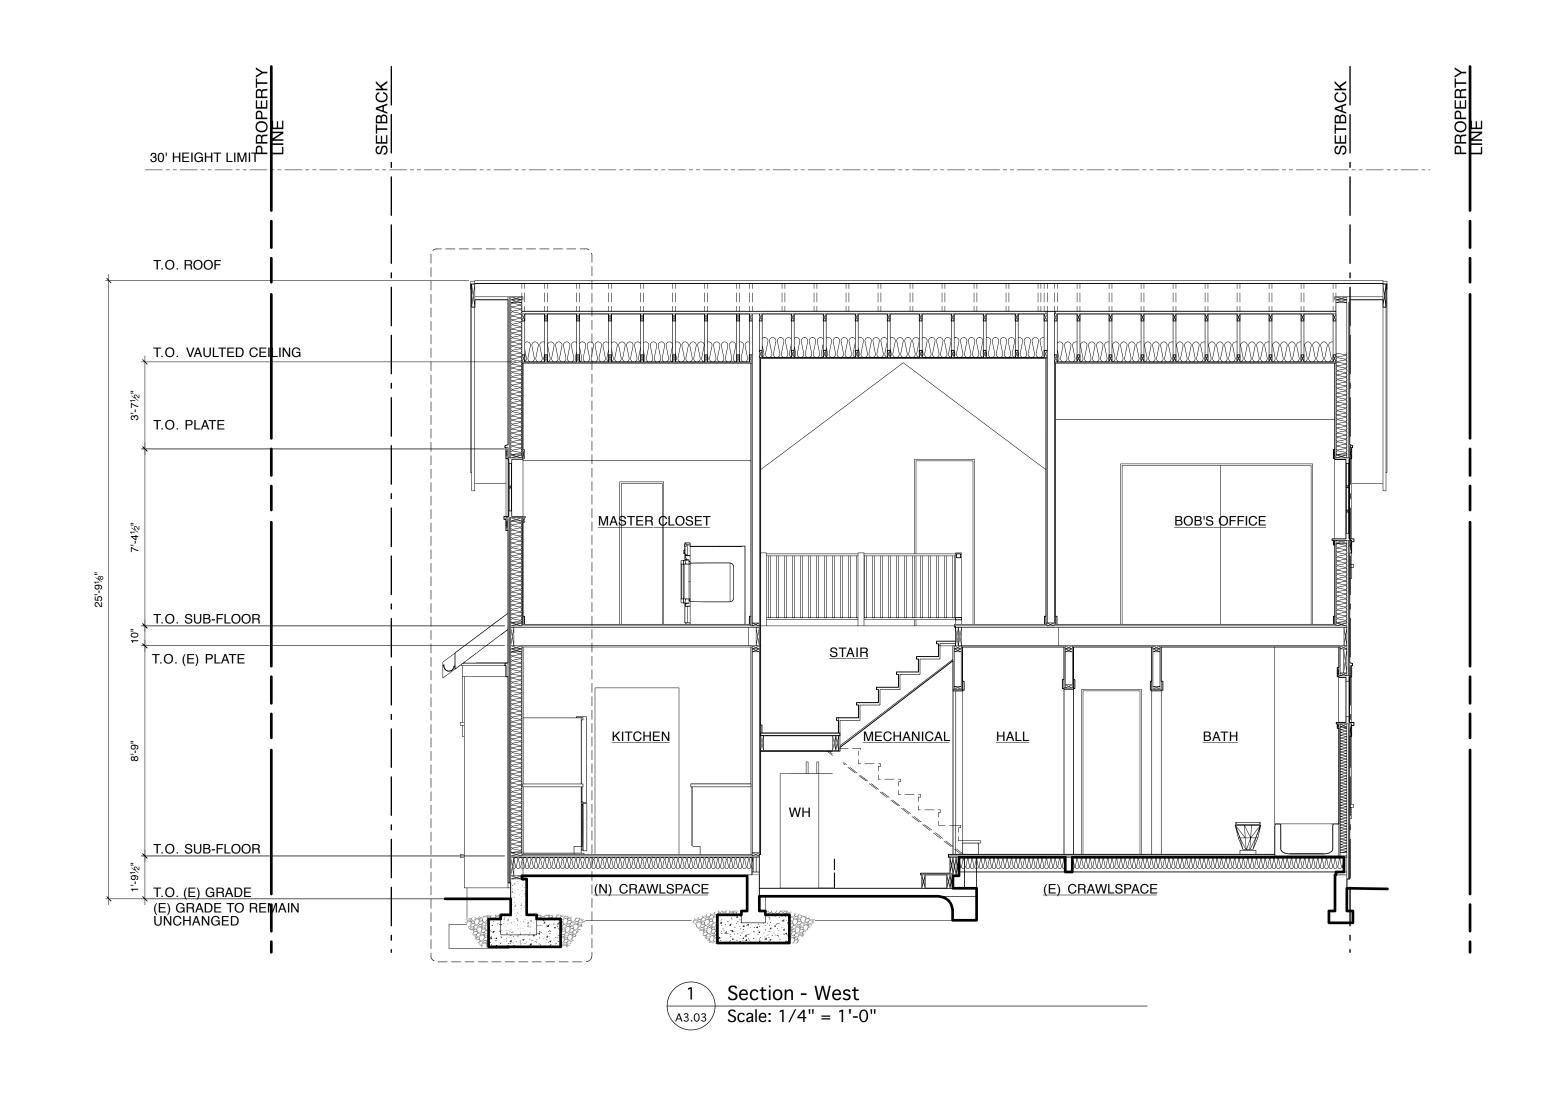

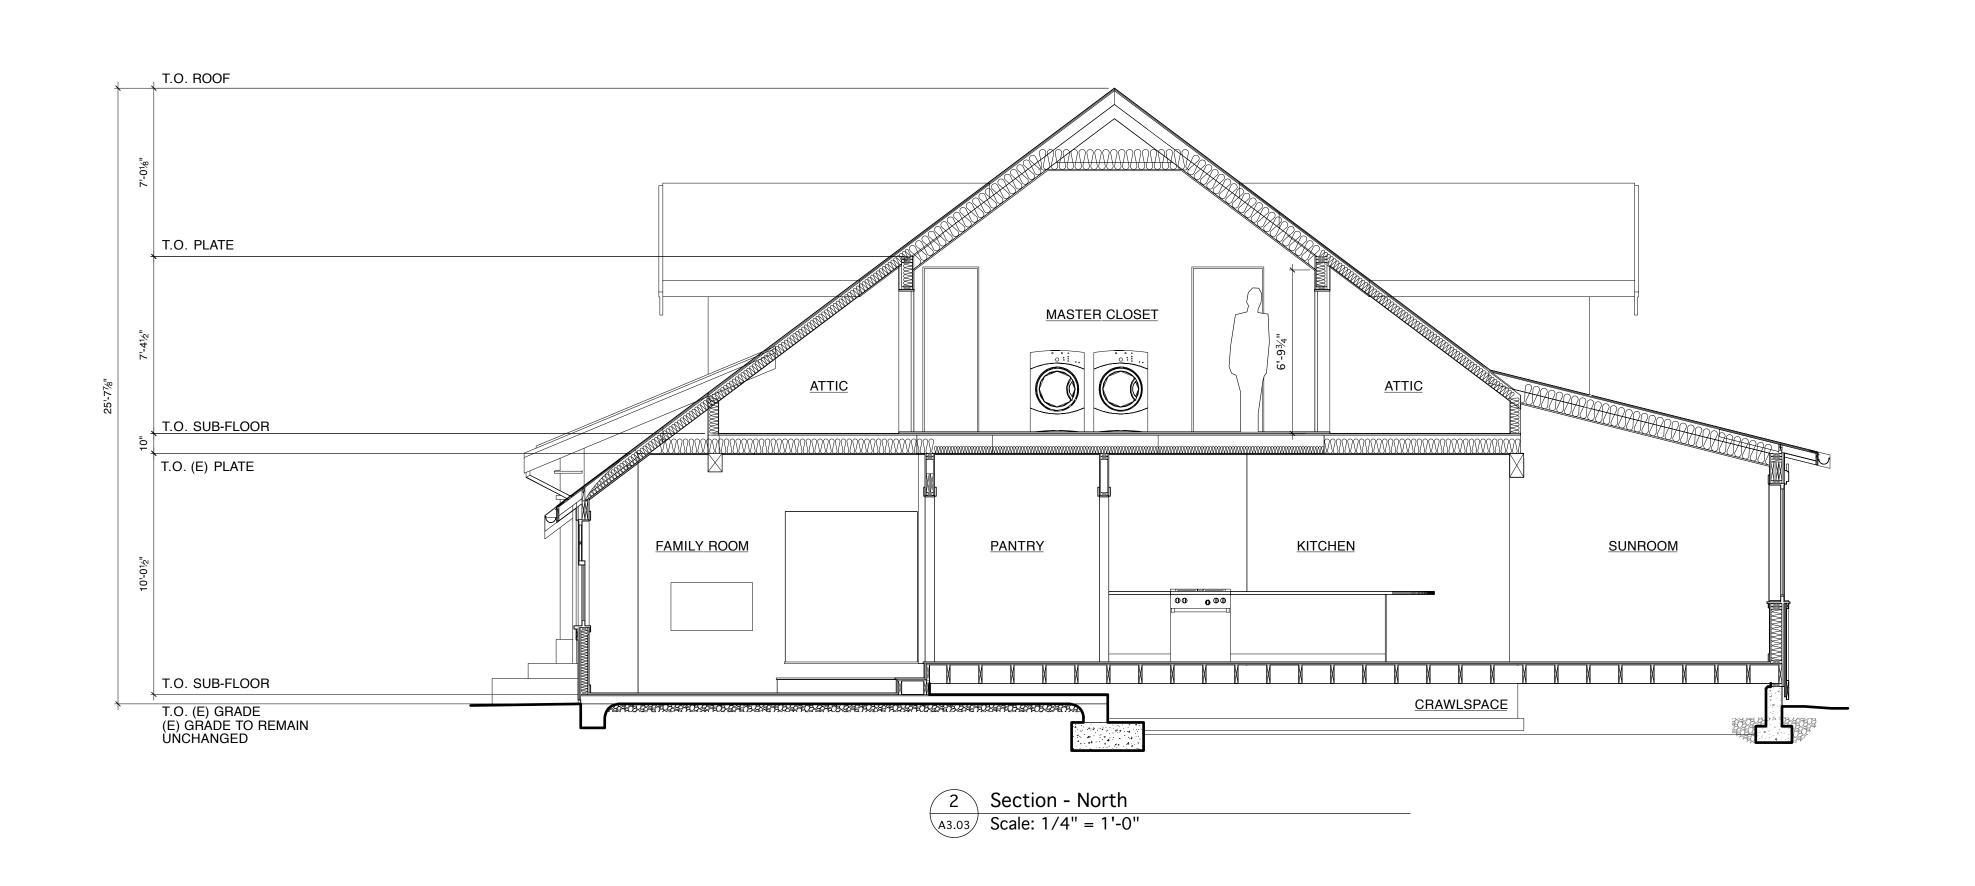

BUILDING SECTIONS

Scale: 1/4" = 1'-0"

20 FT

LEXICON:

Batt insulation. See energy code notes on sheet A1.03

Rigid insulation. See energy code notes on sheet A1.03

Area of reinforced concrete

Key note reference

GENERAL NOTES

- 1. Verify all dimensions prior to construction. Notify architect of any discrepancies immediately.
- 2. See sheets A2.01-2 for floor plans, A2.03 for
- 3. See sheet A2.04 for door & window schedules.
- 4. Insulation shall be approved by the manufacturer for the specific location indicated. Review with architect.
- 5. Repetitive items may be noted only once but shall be provided per note in all areas indicated by drawing.

KEYNOTES 1

Keynote text.



PROJECT:

Archer-Graham Residence

A remodel and addition to an existing single-family residence at:

6556 21st Ave NW



ISSUE DATE:

Mark Issue Type

PLOTTED: June 20, 2012

FILE NAME: 2010 template 2010-08-24.vwx

PROJECT NUMBER

SHEET TITLE:

Permit Set

Building Sections

SHEET NUMBER:

A3.03

SHEET

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